

ROOF FRAMING PLAN

SCALE: 1/4" = 1'-0"

NOTE: SEE SD1 FOR NOTES & SCHEDULES

NOTE:

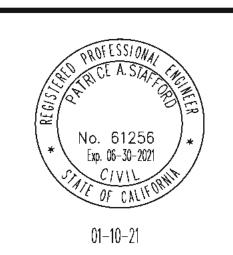
ROOF IS EXISTING WITH NO CHANGE



DESIGN
ENGINEERING
CONSTRUCTION
MANAGEMENT

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PROJECT:

RESIDENCE REMODEL

791 North Cir Dr, Diamond Springs, CA 95619

REVISIONS:

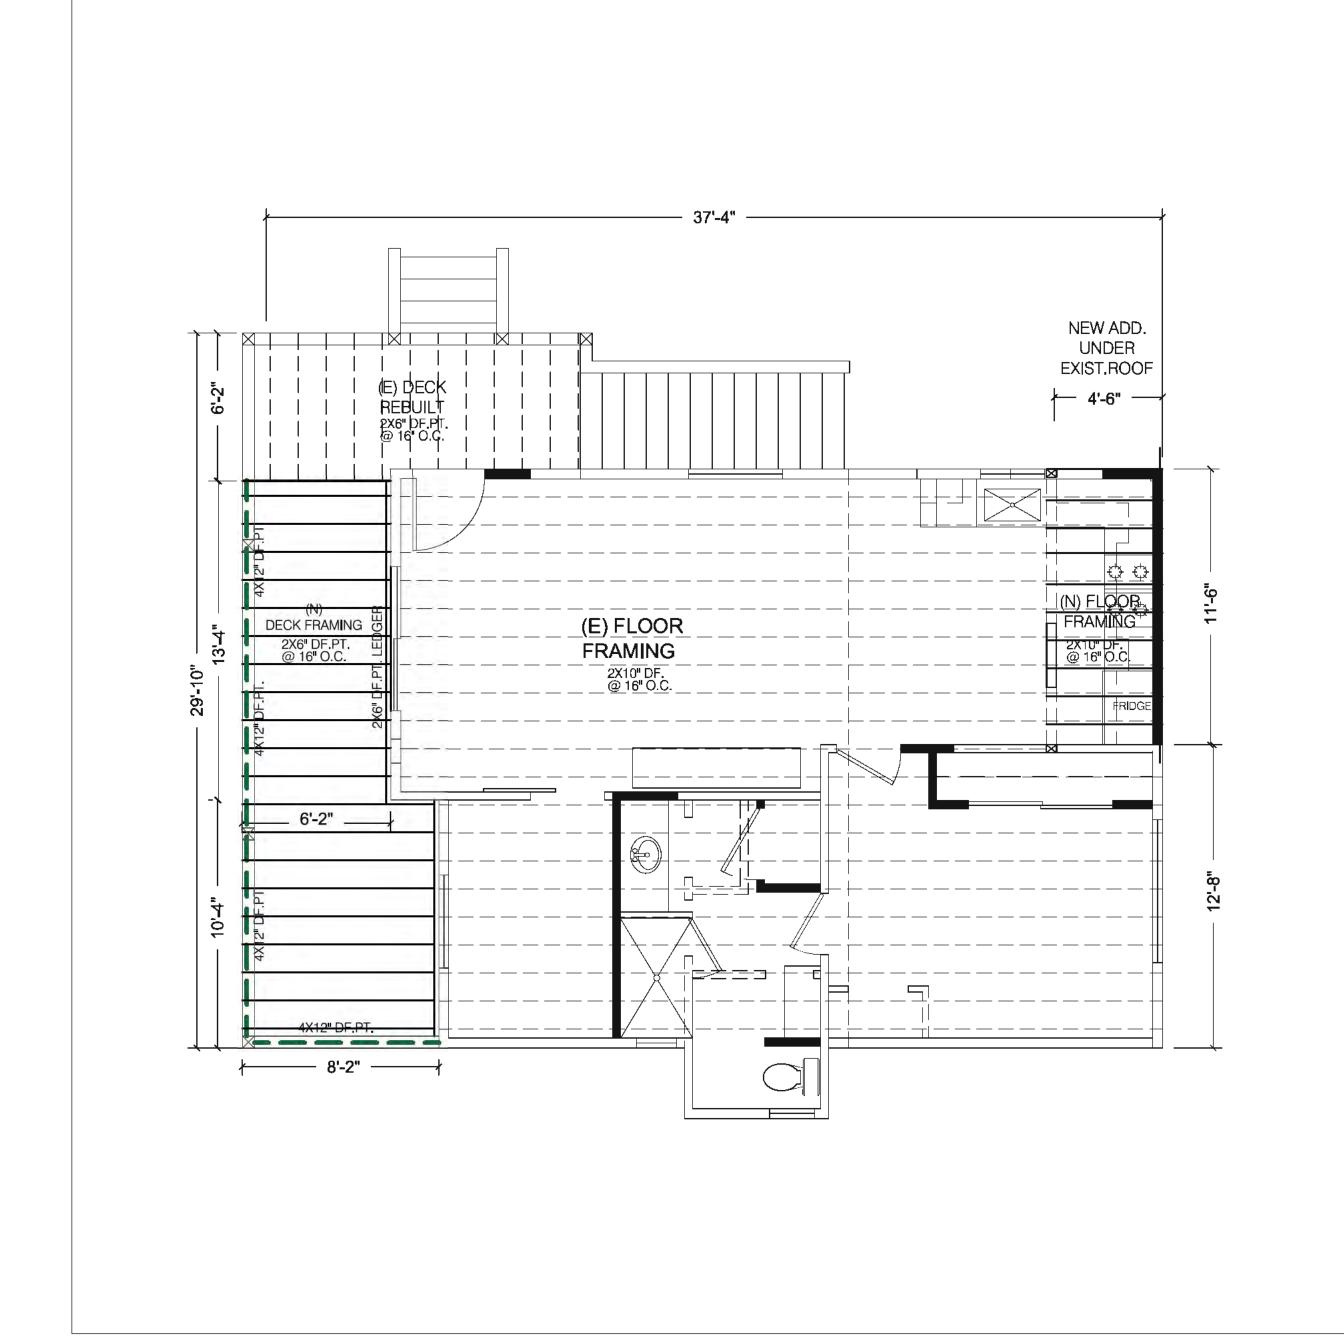
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AWN BY:	N.F
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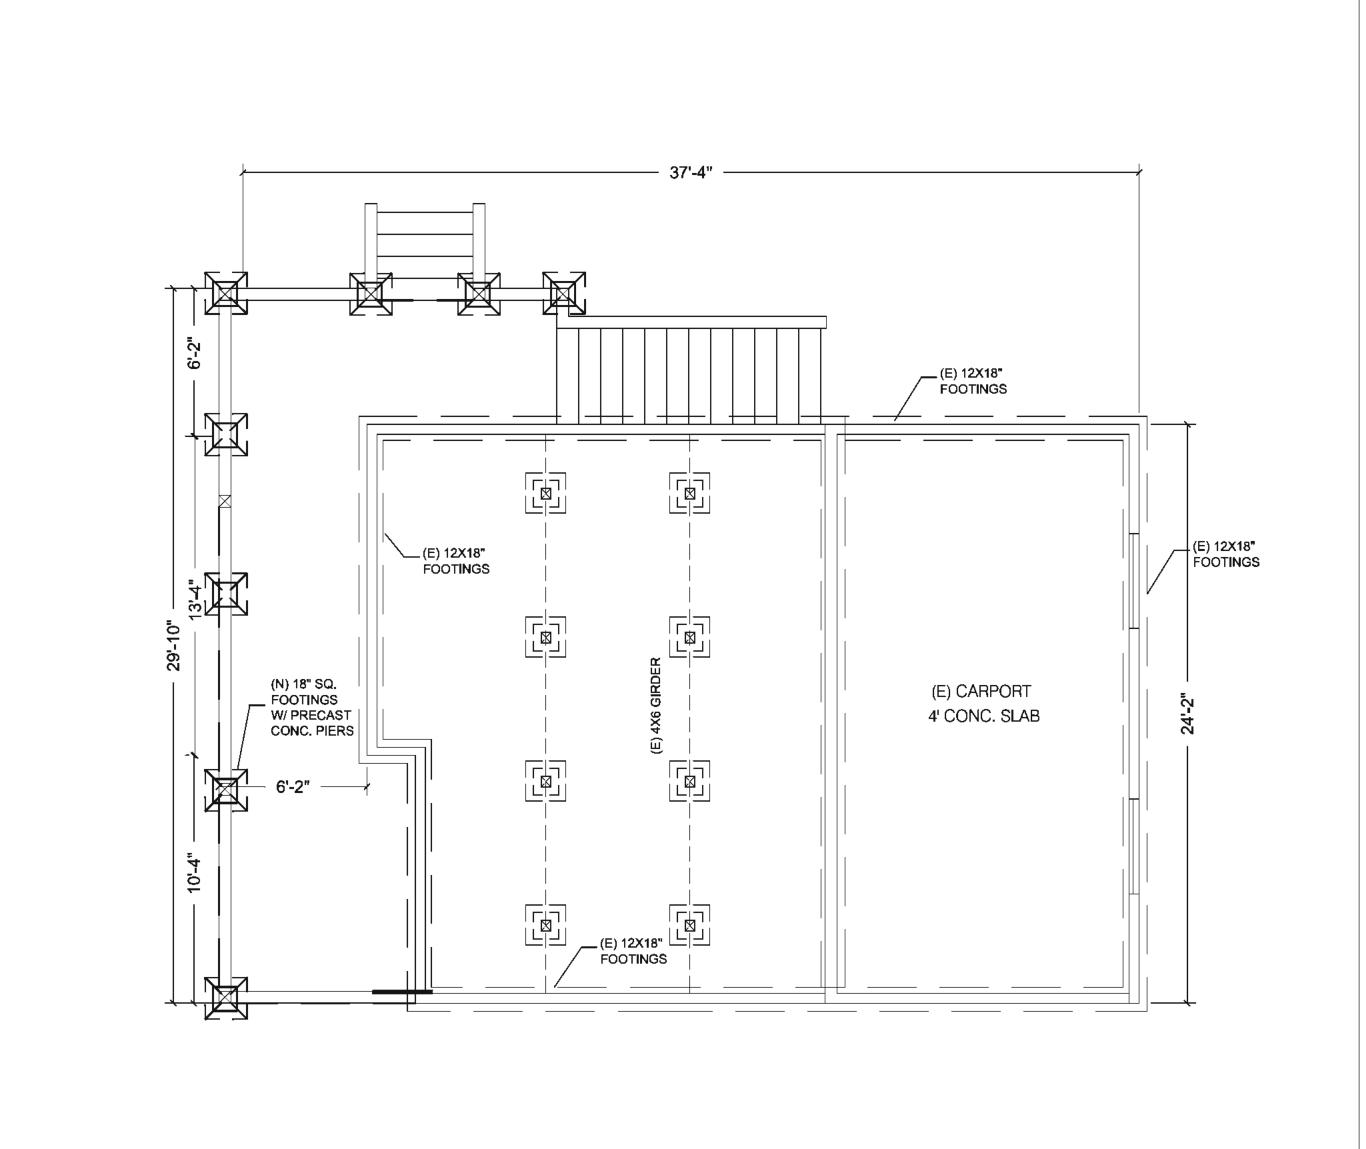
SHEET TITLE:

RESIDENCE ROOF PLAN

SHEET:

S2.0





FLOOR FRAMING PLAN

SCALE: 1/4" = 1'-0"

FOUNDATION PLAN

SCALE: 1/4" = 1'-0"

NOTE: SEE SD1 FOR NOTES & SCHEDULES



WILLIAM CHAMBERS & ASSOCIATES

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SHEET TITLE:

RESIDENCE FOUNDATION AND FLOOR FRAMING

SHEET:

S1.0

LEGEND

DUPLEX OUTLET

□ 1/2 HOT OUTLET

→ AFCI PROTECTED OUTLET

□ 1/2 HOT AFCI PROTECTED OUTLET

€ 220 OUTLET

⊕^{FF} GFCI OUTLET

GFCI OUTLET-WEATHERPROOF

JUNCTION BOX

220v W/ DISCONNECT - WEATHERPROOF

- CEILING MOUNTED LIGHT

PENDANT LIGHT

₩ WALL SCONCE

₩ WALL MOUNTED LIGHT

PHOTO CONTROLLED AND MOTION SENSORED

>▼ ▼ ▼ ▼ WALL MOUNTED LIGHT BAR

→ KEYLESS CEILING MOUNTED LIGHT

WALL MOUNTED LIGHT

RECESSED CAN LIGHT LED

PHOTO CONTROLLED AND MOTION SENSORED RECESSED CAN

EXHAUST FAN

COMBINATION EXHAUST FAN AND LED LIGHT FIXTURE

HIGH EFFICACY LED CLG. MOUNTED LIGHT

© HIGH EFFICACY LED CAN LIGHT 26W

COMBINATION EXHAUST FAN AND LED HIGH EFFICACY LIGHT FIXTURE

→ LED FIXTURE (UNDER CAB.) 15 WATTS

LED FIXTURE (UNDER CAB.) 22 WATTS

LED FIXTURE (UNDER CAB.) 30 WATTS

+∨ SWITCH

↔³ 3-WAY SWITCH

HOP DIMMER SWITCH

DIMMER 3 - WAY SWITCH

OCCUPANT SENSOR SWITCH, MANUAL ON.

SMOKE DETECTOR TO SOUND ALARM AUDIBLE IN ALL SLEEPING AREAS AND SHALL BE

HARDWIRED WITH BATTERY BACKUP.
CARBON MONOXIDE ALARM

HT THERMOSTAT

⊢® PUSHBUTTON

CHIMES

S OPTIONAL SECURITY

TELEPHONE OUTLET

H™ TV OUTLET

⊢© CAMERA

⊢**∳**rg FUEL GAS

FIREPLACE KEY (LOOSE)

HOSE BIBB WITH NON-REMOVABLE BACKFLOW PREVENTION DEVICE

RECESSED STUB-OUT FOR ICE-MAKER

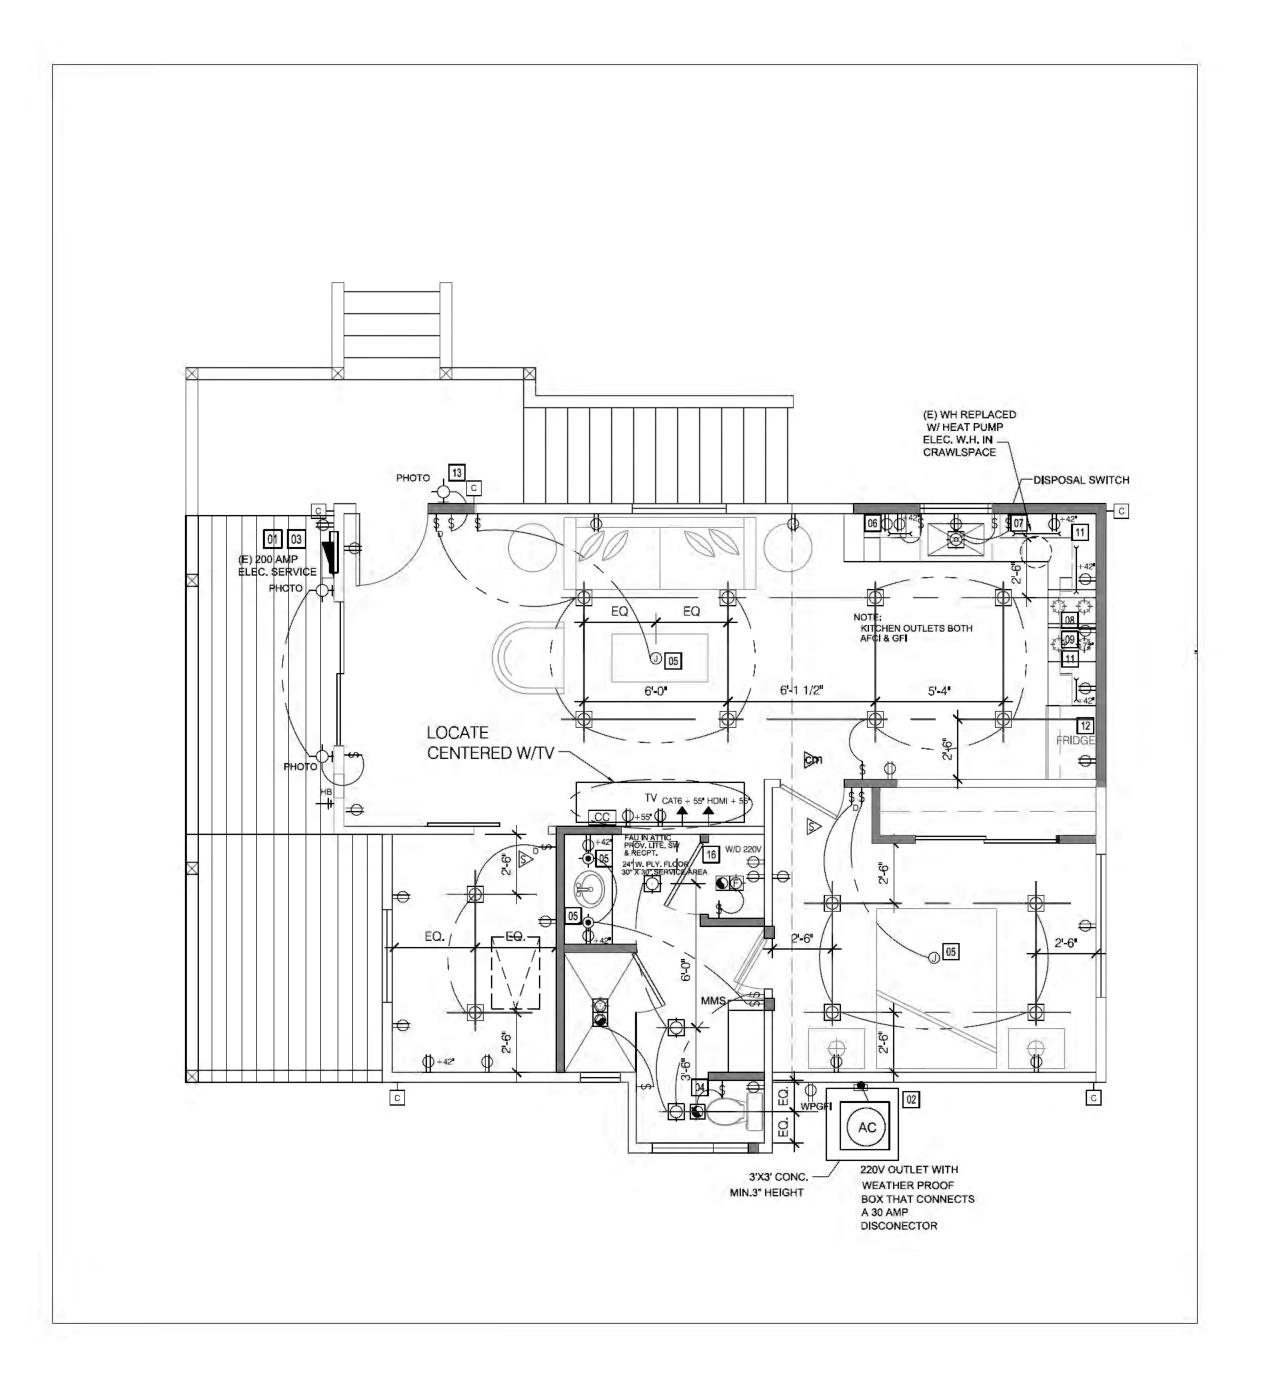
RETURN AIR GRILL

LLUMINATED ADDRESS

12" X 48", LED FIXTURE

0

24" X 48", 3 LED FIXTURE WITH LENS, (32 WATTS EA.) 96 WATTS



ELECTRICAL PLAN

SCALE: 1/4" = 1'-0"

GENERAL ELECTRICAL NOTES

. THE USE OF 110V SMOKE DETECTOR(S) WITH BATTERY BACK UP (WHICH ARE AUDIBLE IN ALL SLEEPING AREAS) AT THE FOLLOWING NEWLY CONSTRUCTED LOCATIONS, SMOKE

- DETECTORS SHALL BE INTERCONNECTED PER CRC R314.3 PROVIDE BOND METALLIC GROUND FOR GAS AND WATER PIPES
- PER CEC 250.104 (a&b)

 3. ALL 15A OR 20A 120 V BRANCH CIRCUITS SUPPLYING OUTLETS (RECEPTACLES LIGHTS, DETECTOR POWER, ETC) ARE REQUIRED TO BE AFCI PROTECTED AT KITCHENS, FAMILY ROOMS, DINING ROOMS, LIVING ROOMS BEDROOMS, RECREATION ROOMS, CLOSET, LAUNDRY ROOMS, HALLWAYS AND
- SIMILAR ROOMS PER CEC 210.12

 4. FIXTURES, LAMP HOLDERS, AND RECEPTACLE SHALL BE SECURELY SUPPORTED. A FIXTURE THAT WEIGHS MORE THAN SIX POUNDS OR EXCEEDS 16" IN ANY DIMENSION, SHALL NOT BE SUPPORTED BY SCREW OF THE SHELL OF A LAMP HOLDER PER CEC 410-20 (a) OUTLET BOXES SHALL NOT BE USED AS THE SOLE SUPPORT FOR CEILING FANS PER CEC 314-27 (d)
- 5. RECEPTACLES SHALL BE SPACED NOT MORE THAN 12' APART AND MINIMUM OF 6' FROM ENDS OF WALLS OR OPENING.
 RECEPTACLES ARE REQUIRED ON WALLS 2' GREATER IN LENGHT PER CEC 210-52 (a)
- CONDUCTOR WIRES WITH INSULATED NEUTRAL AND A FOUR PRONG OUTLET IS REQUIRED FOR DRYERS AND COOKING APPLIANCE PER
- CEC 250-140

 7. BATHROOM RECEPTACLES SHALL BE SUPPLIED BY ONE 20 AMP CIRCUIT SUCH CIRCUIT SHALL HAVE NO OTHER OUTLETS PER CEC 210-52 (d)
- 8. ALL KITCHEN AND BATHROOM LIGHT FIXTURES TO HAVE A MINIMUM EFFICACY OF 40 LUMENS PER WATT.

 9. STEEL ELECTRICAL BOXES ARE REQUIRED IN FIRE-RESISTIVE WALLS AND CEILINGS, SEPARATE ELECTRICAL BOXES BACK TO BACK IN FIRE RESISTIVE WALLS AND CEILINGS BY A MINIMUM OF 24"
- PUTTY-PADS) AND BOX AREA SHALL NOT EXCEED 16 IN 2
 PER CRC R302.4.4.2 #1

 10. OUTLET BOXES OR OUTLET BOX SYSTEMS USED AS THE SOLE
 SUPPORT FOR CEILING (PADDLE) FANS, SHALL BE LISTED, SHALL
 BE MARKED BY THEIR MFR. AS SUITABLE FOR THIS PURPOSE AND
 SHALL NOT SUPPORT CEILING-SUSPENDED (PADDLE) FANS THAT
 WEIGH MORE THAN 32kg (70lb). PER CEC 314-27 (d) AND 422.18

 11. MINIMUM OF ONE RECEPTACLE IS REQUIRED IN ADDITION TO ANY
 PROVIDED FOR LAUNDRY EQUIPMENT, AND SHALL BE INSTALLED

HORIZONTALLY (OR BY PROTECTING BOTH BOXES WITH LISTED

- IN LAUNDRY ROOM/AREAS PER CEC 210-52 (f)

 12. PROVIDE TWO SMALL APPLIANCE BRANCH CIRCUIT FOR THE KITCHEN AND LIMITED TO SUPPLYING WALL AND COUNTER SPACE OUTLET. NOTE, THEY CANNOT SERVE OUTSIDE SPACE RECEPTACLE RANGE HOOD, DISPOSALS, DISH WASHERS OR MICROWAVE, ONLY THE REQUIRED COUNTERTOP/WALL OUTLET INCLUDING THE REFRIGERATOR. PER CEC 210-52 (b)
- 13. ALL 15 AND 20 AMP RECEPTACLE OUTLETS IN THIS DWELLING UNIT SHALL
- BE TAMPER RESISTANT RECEPTACLES.

 14. GFCI PROTECTION IS REQUIRED FOR ALL 15A, AND 20A, 125V RECEPTACLES INSTALLED IN THE FOLLOWING LOCATIONS:
 SINKS- GFCI PROTECTION IS REQUIRED WITHIN AN ARC MEASUREMENT OF 6' FROM OUTSIDE EDGE OF A SINK
 BATHTUBS OR SHOWER STALLS- GFCI PROTECTION IS REQUIRED FOR RECEPTACLES LOCATED WITHIN 6' OF THE OUTSIDE EDGE OF A BATHTUB OR SHOWER STALL.
 LAUNDRY AREAS- RECEPTACLES INSTALLED IN LAUNDRY AREAS OF A DWELLING UNIT SHALL BE
- THE BRANCH CIRCUIT SERVING THE GARAGE RECEPTACLES SHALL NOT SERVE OUTLETS OUTSIDE OF THE GARAGE.

FLOOR PLAN NOTES

GFCI PROTECTED

01 MAIN ELECTRICAL PANEL AND METER - 400 AMP
02 FUSED DISCONNECT WEATHERPROOF ENCLOSURE, VERIFY LOCATION.

03 EXIST. TELEPHONE AND CABLE POC
04 BATH FANS:
PANASONIC WHISPER GREEN TO BE CONTROLLED BY A HUMIDISTAT

AND ENERGY STAR RATED

05 DECORATIVE LIGHT FIXTURE
06 DEDICATED GFI DISH WASHER OULET

07 SWITCHED DUPLEX OUTLET FOR GARBAGE DISPOSAL
08 PROVIDE DUPLEX OUTLET FOR HOOD

09 PROVIDE DUPLEX OUTLET FOR RANGE

10 DEDICATED RECEPTACLE FOR SPRINKLER TIMER
 11 DEDICATED MICROWAVE OUTLET

11 DEDICATED MICROWAVE OUTLET

12 DEDICATED REFRIGERATOR OUTLET

DOOR BELL CHIME AT +84" - LOCATE STEP DOWN TRANSFORMER IN GARAGE

CARBON MONOXIDE NOTE

CARBON MONOXIDE ALARMS SHALL BE INSTALLED WITH BATTERY BACK-UP IN DWELLING UNITS WITH FUEL BURNING APPLIANCES OR WITH ATTACHED GARAGES, WHERE MORE THAN ONE CARBON MONOXIDE ALARM IS REQUIRED TO BE INSTALLED THE ALARM SHALL BE INTERCONNECTED IN A MANNER THAT ACTIVATION OF ONE ALARM SHALL ACTIVATE ALL OF THE ALARMS IN THE INDIVIDUAL UNIT PER CRC R315 AND SHALL BE "LISTED" AS COMPLYING WITH UL 2034 AND UL 2074 PER CRC R315.3

TITLE 24 LIGHTING NOTES

2016 CALIFORNIA ENERGY CODE MANDATORY MEASUREMENTS FOR RESIDENTIAL LIGHTING:

- ALL PERMANENTLY INSTALLED LUMINARIES IN DWELLING UNITS SHALL BE HIGH EFFICACY AND HAVE MANUAL ON/OFF CONTROLS AND VACANCY SENSORS OR DIMMERS EXCEPT FOR HALLWAYS & CLOSETS LESS THAN 70 sq.ft.
- EXHAUST FANS MUST BE SWITCHED SEPARATE FROM LIGHTING OR UTILIZE A DEVICE WHERE LIGHTING CAN BE TURNED OFF WHILE THE FAN IS RUNNING. EXCLUDES KITCHEN EXHAUST HOOD.
- UNDER CABINET LIGHTING MUST BE SWITCHED SEPARATE FROM ALL OTHER LIGHTING.
- PERMANENTLY INSTALLED LIGHTING IN CABINETS MUST BE HIGH EFFICACY.
- LIGHTING IN BATHROOMS, GARAGES, LAUNDRY ROOMS & UTILITY ROOMS MUST HAVE AT LEAST ONE LUMINAIRE CONTROLLED BY VACANCY SENSORS.
 PERMANENTLY INSTALLED OUTDOOR LIGHTING ATTACHED TO RESIDENCE OR OTHER
- BUILDINGS MUST BE HIGH EFFICACY AND MUST BE CONTROLLED BY A MANUAL ON AND OFF SWITCH AND USE ONE OF THESE CONTROL TYPES:
- PHOTO-CONTROL AND MOTION SENSOR OR
 PHOTO-CONTROL AND AUTOMATIC TIME SWITCH CONTROL OR ASTRONOMICAL TIME CLOCK THAT AUTOMATICALLY TURNS OUTDOOR LIGHTING OFF DURING DAYLIGHT HOURS OR
- ENERGY MANAGEMENT CONTROL SYSTEM (EMCS) THAT PROVIDES THE FUNCTIONALLY OF AN ASTRONOMICAL TIME CLOCK.

WHOLE HOUSE VENTILATION:

LAUNDRY ROOM BROAN MODEL XB50

PROVIDE A SWITCH WHICH IS LABELED "FAN SHOULD BE ON WHENEVER THE HOME IS OCCUPIED"

THE SYSTEM MUST BE DESIGNED SO IT CAN OPERATE AUTOMATICALLY BASED ON A TIMER,

THE INTERMITTENT MECHANICAL VENTILATION SYSTEM MUST OPERATE FOR AT LEAST ONE HOUR
PER DAY AND MUST OPERATE AT LEAST 10% OF THE TIME.

THE VENTILATION AIRFLOW IS INCREASED TO RESPOND TO THE FEWER HOURS OF FAN OPERATION
AND THE TENDENCY OF POLLUTANT CONCENTRATIONS TO BUILD UP DURING OFF CYCLES.

THE FAN MUST BE LISTED AT 1 SONE OR LESS FOR NOISE.

RATING BASED ON WATER COLUMN OF .25 OR GREATER

6" MIN DUCT SIZE

KITCHEN HOOD EXHAUST:

Z LINE 36" 1200 CFM 6" MIN DUCT SIZE

6" MIN DUCT SIZE RATING BASED ON WATER COLUMN OF .25 OR GREATER



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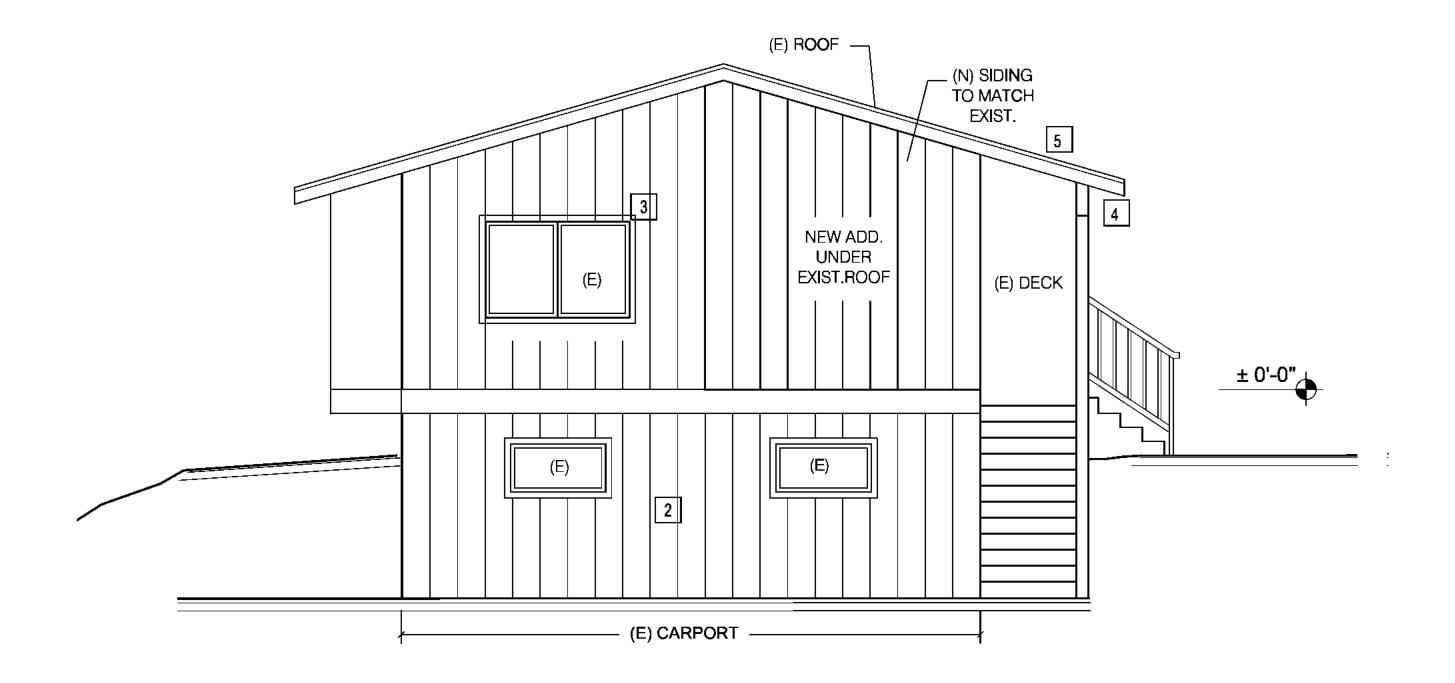
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RESIDENCE ELECTRICAL PLAN

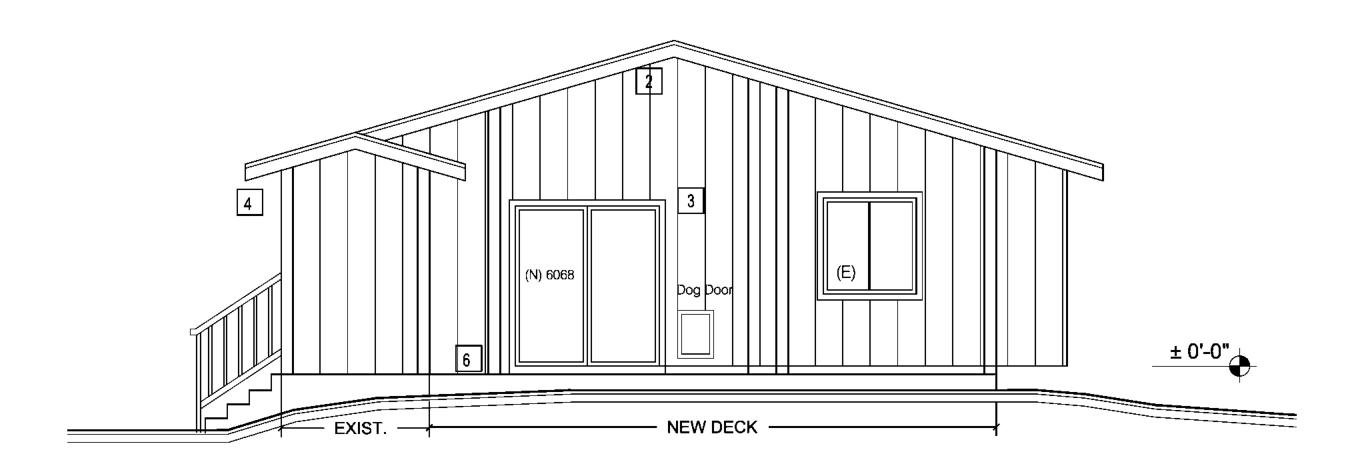
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LEFT ELEVATION

SCALE: 1/4" = 1'-0"



RIGHT ELEVATION

SCALE: 1/4" = 1'-0"

KEYNOTES

- 1 STANDING SEAM METAL ROOF
- 2 HARDI SIDING BOARD AND BATTEN
- TRIM AROUND ALL WINDOWS & DOORS
- 4 PREFORMED METAL GUTTER
- 5 FASCIA
- 6 TREX DECK



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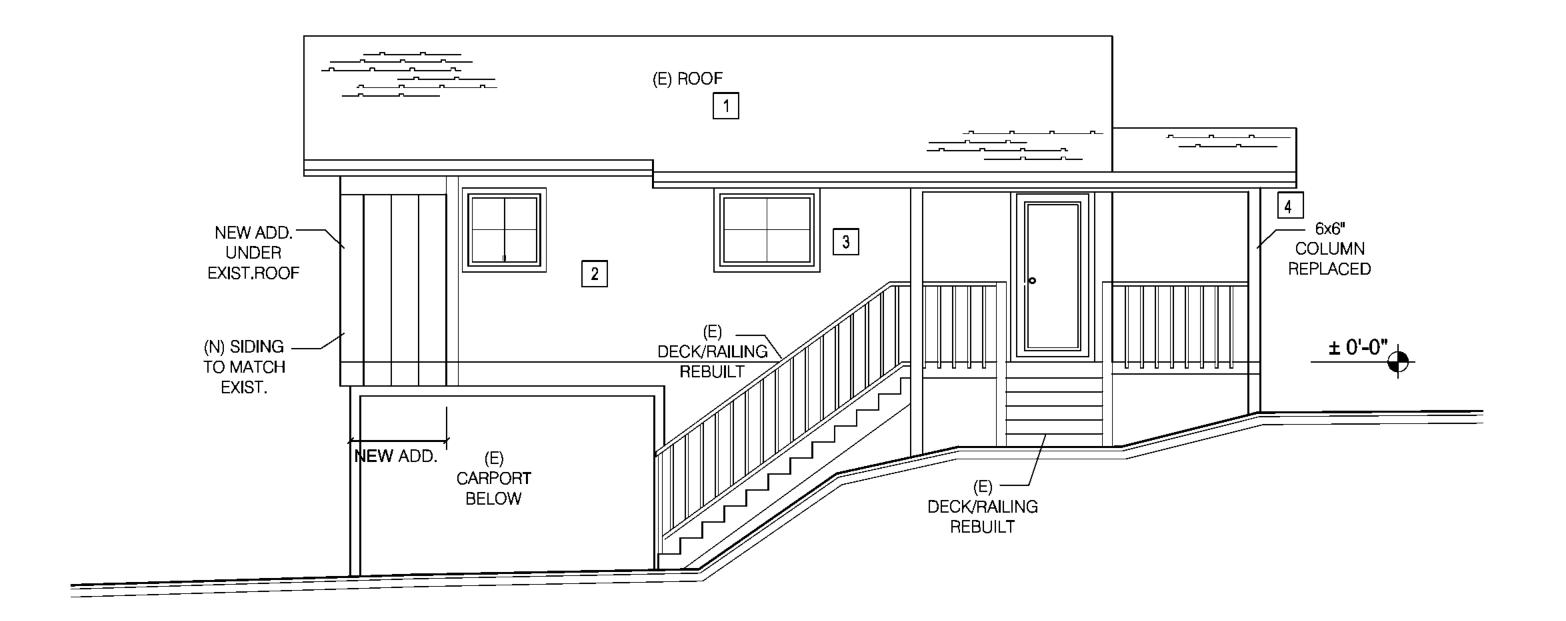
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RESIDENCE EXTERIOR ELEVATIONS

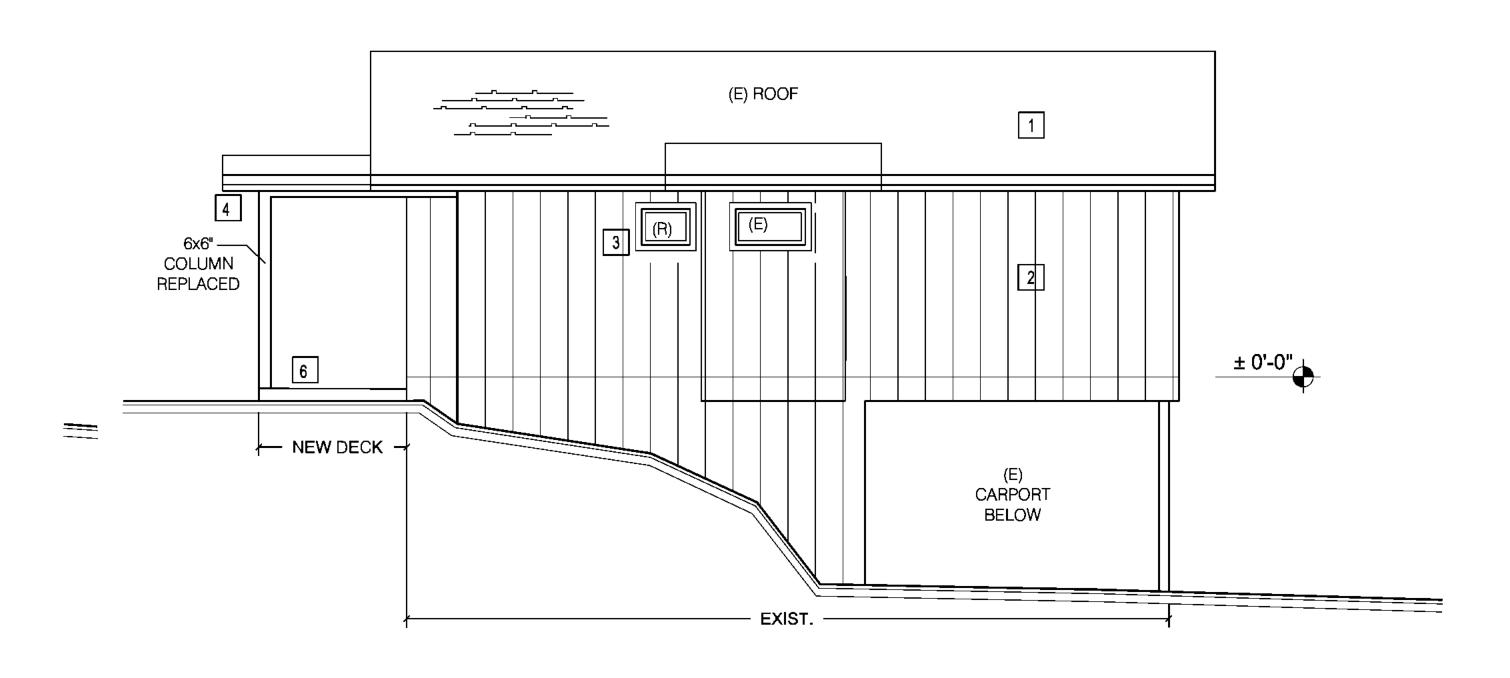
SHEET:

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FRONT ELEVATION

SCALE: 1/4" = 1'-0"



REAR ELEVATION

SCALE: 1/4" = 1'-0"

KEYNOTES

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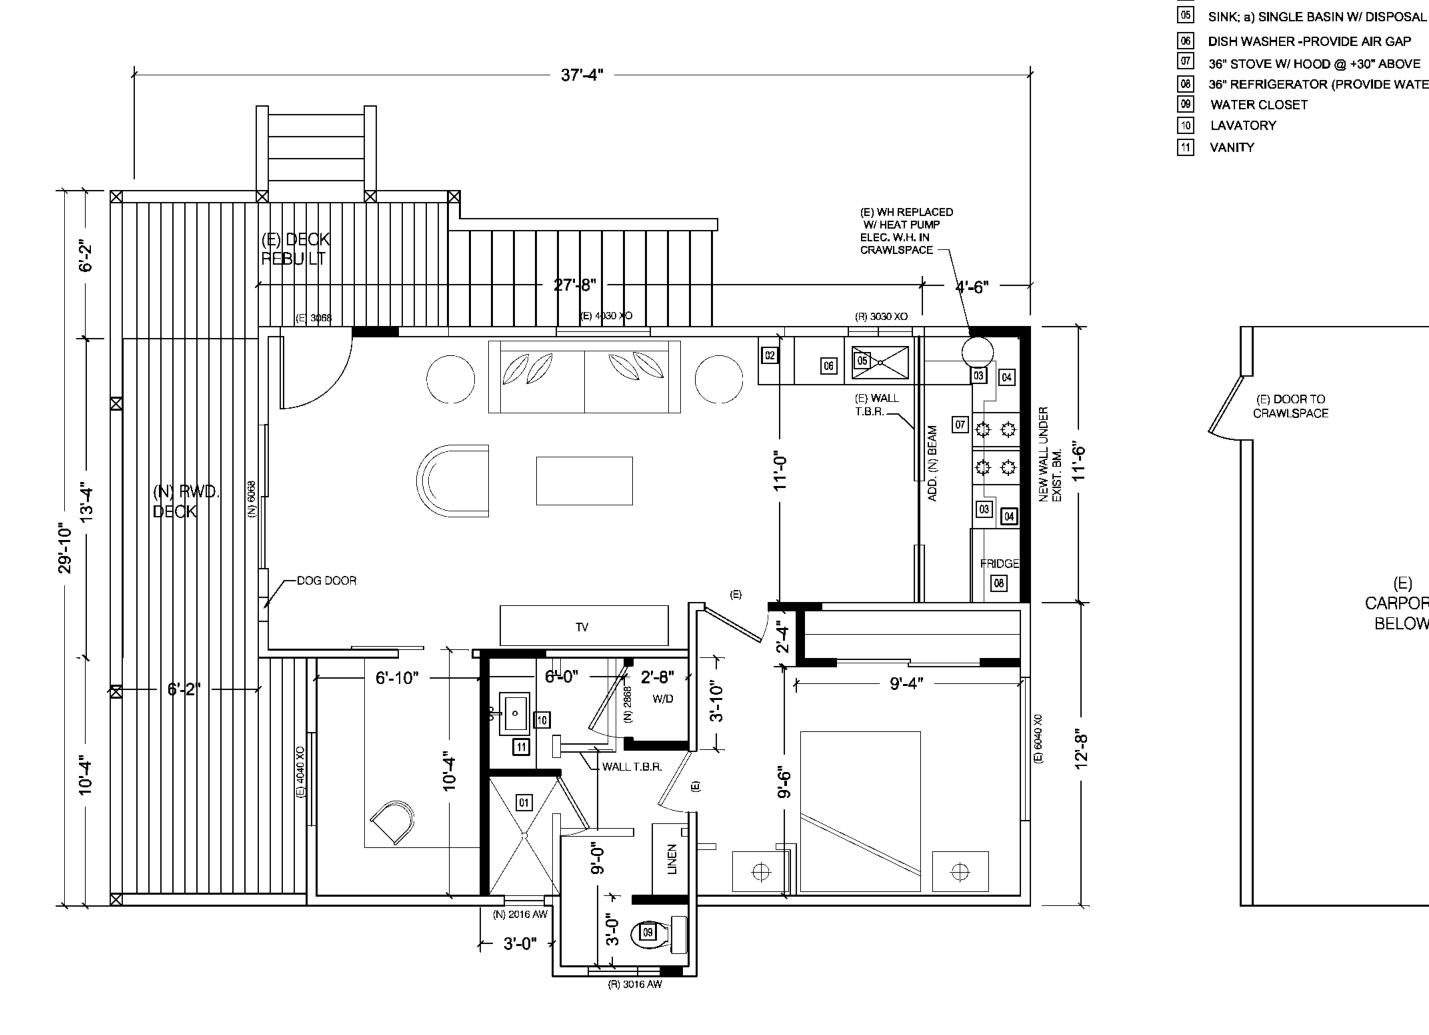
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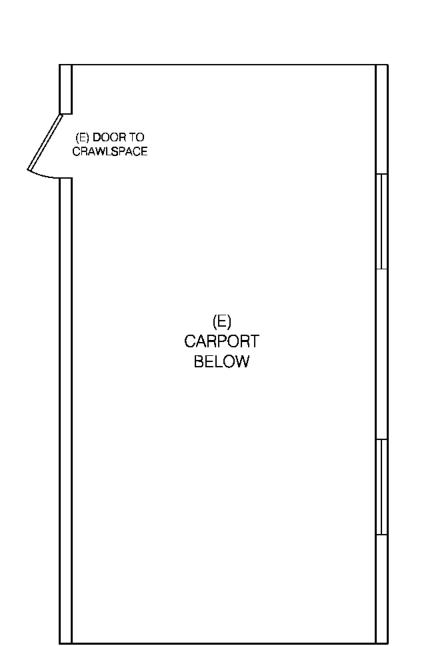
RESIDENCE EXTERIOR ELEVATIONS

SHEET:

A2.0

NOTE: SEE AD1&2 FOR EXTERIOR DETAILS





TILE SHOWER W/ MUD SET TILE WAINSCOT TO +72 PER CRC R 307.2 OVER LISTED HARDI BACKER BD, NO PAPER BACKED WALL BD,

36" HIGH COUNTER

WATER CLOSET

LINE OF UPPER CABINET

DISH WASHER -PROVIDE AIR GAP

36" REFRIGERATOR (PROVIDE WATER STUB)

SCALE: 1/4" = 1'-0"

ALL PENETRATIONS INCLUDING CENTRAL VACUUM, PLUMBING, ELECTRICAL AND MECHANICAL RUNS THROUGH FIRE RATED ASSEMBLIES SHALL ME METALLIC EXTENDING A MINIMUM 12" FROM FACE OF WALL (INCLUDING TRAPS WHERE APPLICABLE)
AND SHALL BE SEALED SO THAT HOT GASES CANNOT PASS THROUGH PER CRC R302.5 HOSE BIB WITH NON REMOVABLE BACKFLOW PREVENTION

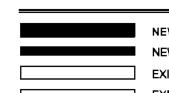
DEVICE PER CRC R602,0 AND R603,3

WATER PIPING TO "PEX" PIPING, CONTRACTOR TO SUBMIT AN "ALTERNATE MATERIALS AND METHODS OF CONSTRUCTION" FORM TO THE BUILDING DEPT. FOR APPROVAL. PROVIDE MANUFACTURER LISTING AND INSTALLATION GUIDE LINES OF MATERIALS.

IN FRONT THE WATER CLOSET PER CPC 402.5

SHOWERS and TUB/SHOWER COMBINATION SHALL BE PROVIDED with PRESSURE BALANCE or THERMOSTATIC MIXING CONTROL VALVES HANDLE POSITION STOPS SHALL BE ADJUSTED TO ALLOW A MAXIMUM WATER SETTING OF 120°F (49°C) PER CPC 408.6 SHOWER COMPARTMENT SHALL BE A MIN. FLOOR AREA 1,024 SQ. INCHES AND ENCOMPASS A 30" DIA. CIRCLE PER CPC 408.6 WATER CLOSET TO BE MAX 1.28 GALLONS PER FLUSH PER CPC 403.2 AND SHALL NOT BE INSTALLED CLOSER THA 15" FROM ITS CENTER TO ANY WALL OR OBSTRUCTION NOT CLOSER THA 30" CENTER TO CENTER OF ANY WALL OR OBSTRUCTION WITH A MIN. 24" CLEAR FLOOR SPACE

WALL LEGEND



NEW 2X6 DF#2 @ 16" O.C WOOD FRAMED WALL NEW 2X4 DF#2 @ 16" O.C WOOD FRAMED WALL EXIST. 2X6 DF#2 @ 16" O.C WOOD FRAMED WALL EXIST. 2X4 DF#2 @ 16* O.C WOOD FRAMED WALL

EXIST. 2X4 WALL TO BE REMOVED WALL

EGRESS NOTE

PROVIDE OPERABLE DOOR OR WINDOW, APPROVED FOR EMERGENCY ESCAPE, WHICH SHALL OPEN DIRECTLY INTO A PUBLIC STREET ALLEY, YARD OR EXIT COURT, FOR EVERY SLEEPING ROOM BELOW THE FOURTH STORY PER CRCR310.1 OPENING SHALL COMPLY
A. MAXIMUM FINISHED SILL HEIGHT OF NOT MORE THAN 44"

- INCHES ABOVE THE FLOOR. B. SHALL HAVE A MINIMUM NET CLEAR OPEN ABLE AREA OF
- 5.7 SQ. FEET C. THE MINIMUM NET CLEAR OPEN ABLE HEIGHT DIMENSION
- SHALL BE 24" INCHES D. THE MINIMUM NET CLEAR OPEN ABLE WIDTH DIMENSION
- SHALL BE 20" INCHES E. ALL WINDOW CASEMENT (C).

S.W LEGEND

BRACED WALL FRAMING PER 2016 CRC CS-WSP SEE SHEET SD1

BRACED WALL PANELS W/ 3/8" PLY. W/ 8d NAILING @ 6" C.C. 5/8" GWB TYP. @ INT.SIDE OF WALL

ALTERNATE BRACED WALL PANELS W/ 3/8" PLY. W/ 8d NAILING @ 6" C.C. AND HOLDOWN PER SCHEDULE 5/8" GWB TYP. @ INT.SIDE OF WALL

SHEAR WALL PANELS W/ 3/8" PLY. W/ 8d NAILING @ 6" C.C.

WINDOW NOTES

AW AWNING

C CASEMENT E EYEBROW F FIXED XO SLIDING

T TEMPERED

WINDOW NOTATIONS:



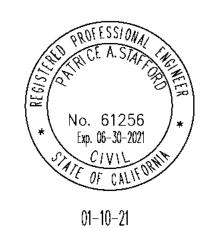
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RESIDENCE 1ST FLOOR PLAN

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A1.0

