

### ROOF FRAMING PLAN SCALE: 1/4" = 1'-0"

SEE SD1 FOR NOTES & SCHEDULES

NOTE:

NOTE:

ROOF IS EXISTING WITH NO CHANGE




### WILLIAM CHAMBERS & ASSOCIATES

DESIGN
ENGINEERING
CONSTRUCTION
MANAGEMENT

950 FULTON AVE. SUITE 125 Sacramento | Ca | 95825

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PROJECT:

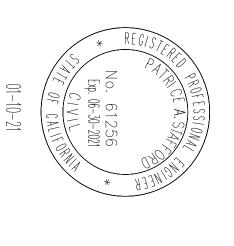RESIDENCE REMODEL

791 North Cir Dr,

Diamond Springs, CA 95619

SCALE:
DRAWN BY:
DATE: REVISIONS: AS SHOWN N.R. JAN, 2021

RESIDENCE ROOF PLAN

JOB NUMBER:

SHEET TITLE:


CHECKED BY:

W.C.

##

SHEET:

**S2.0** 

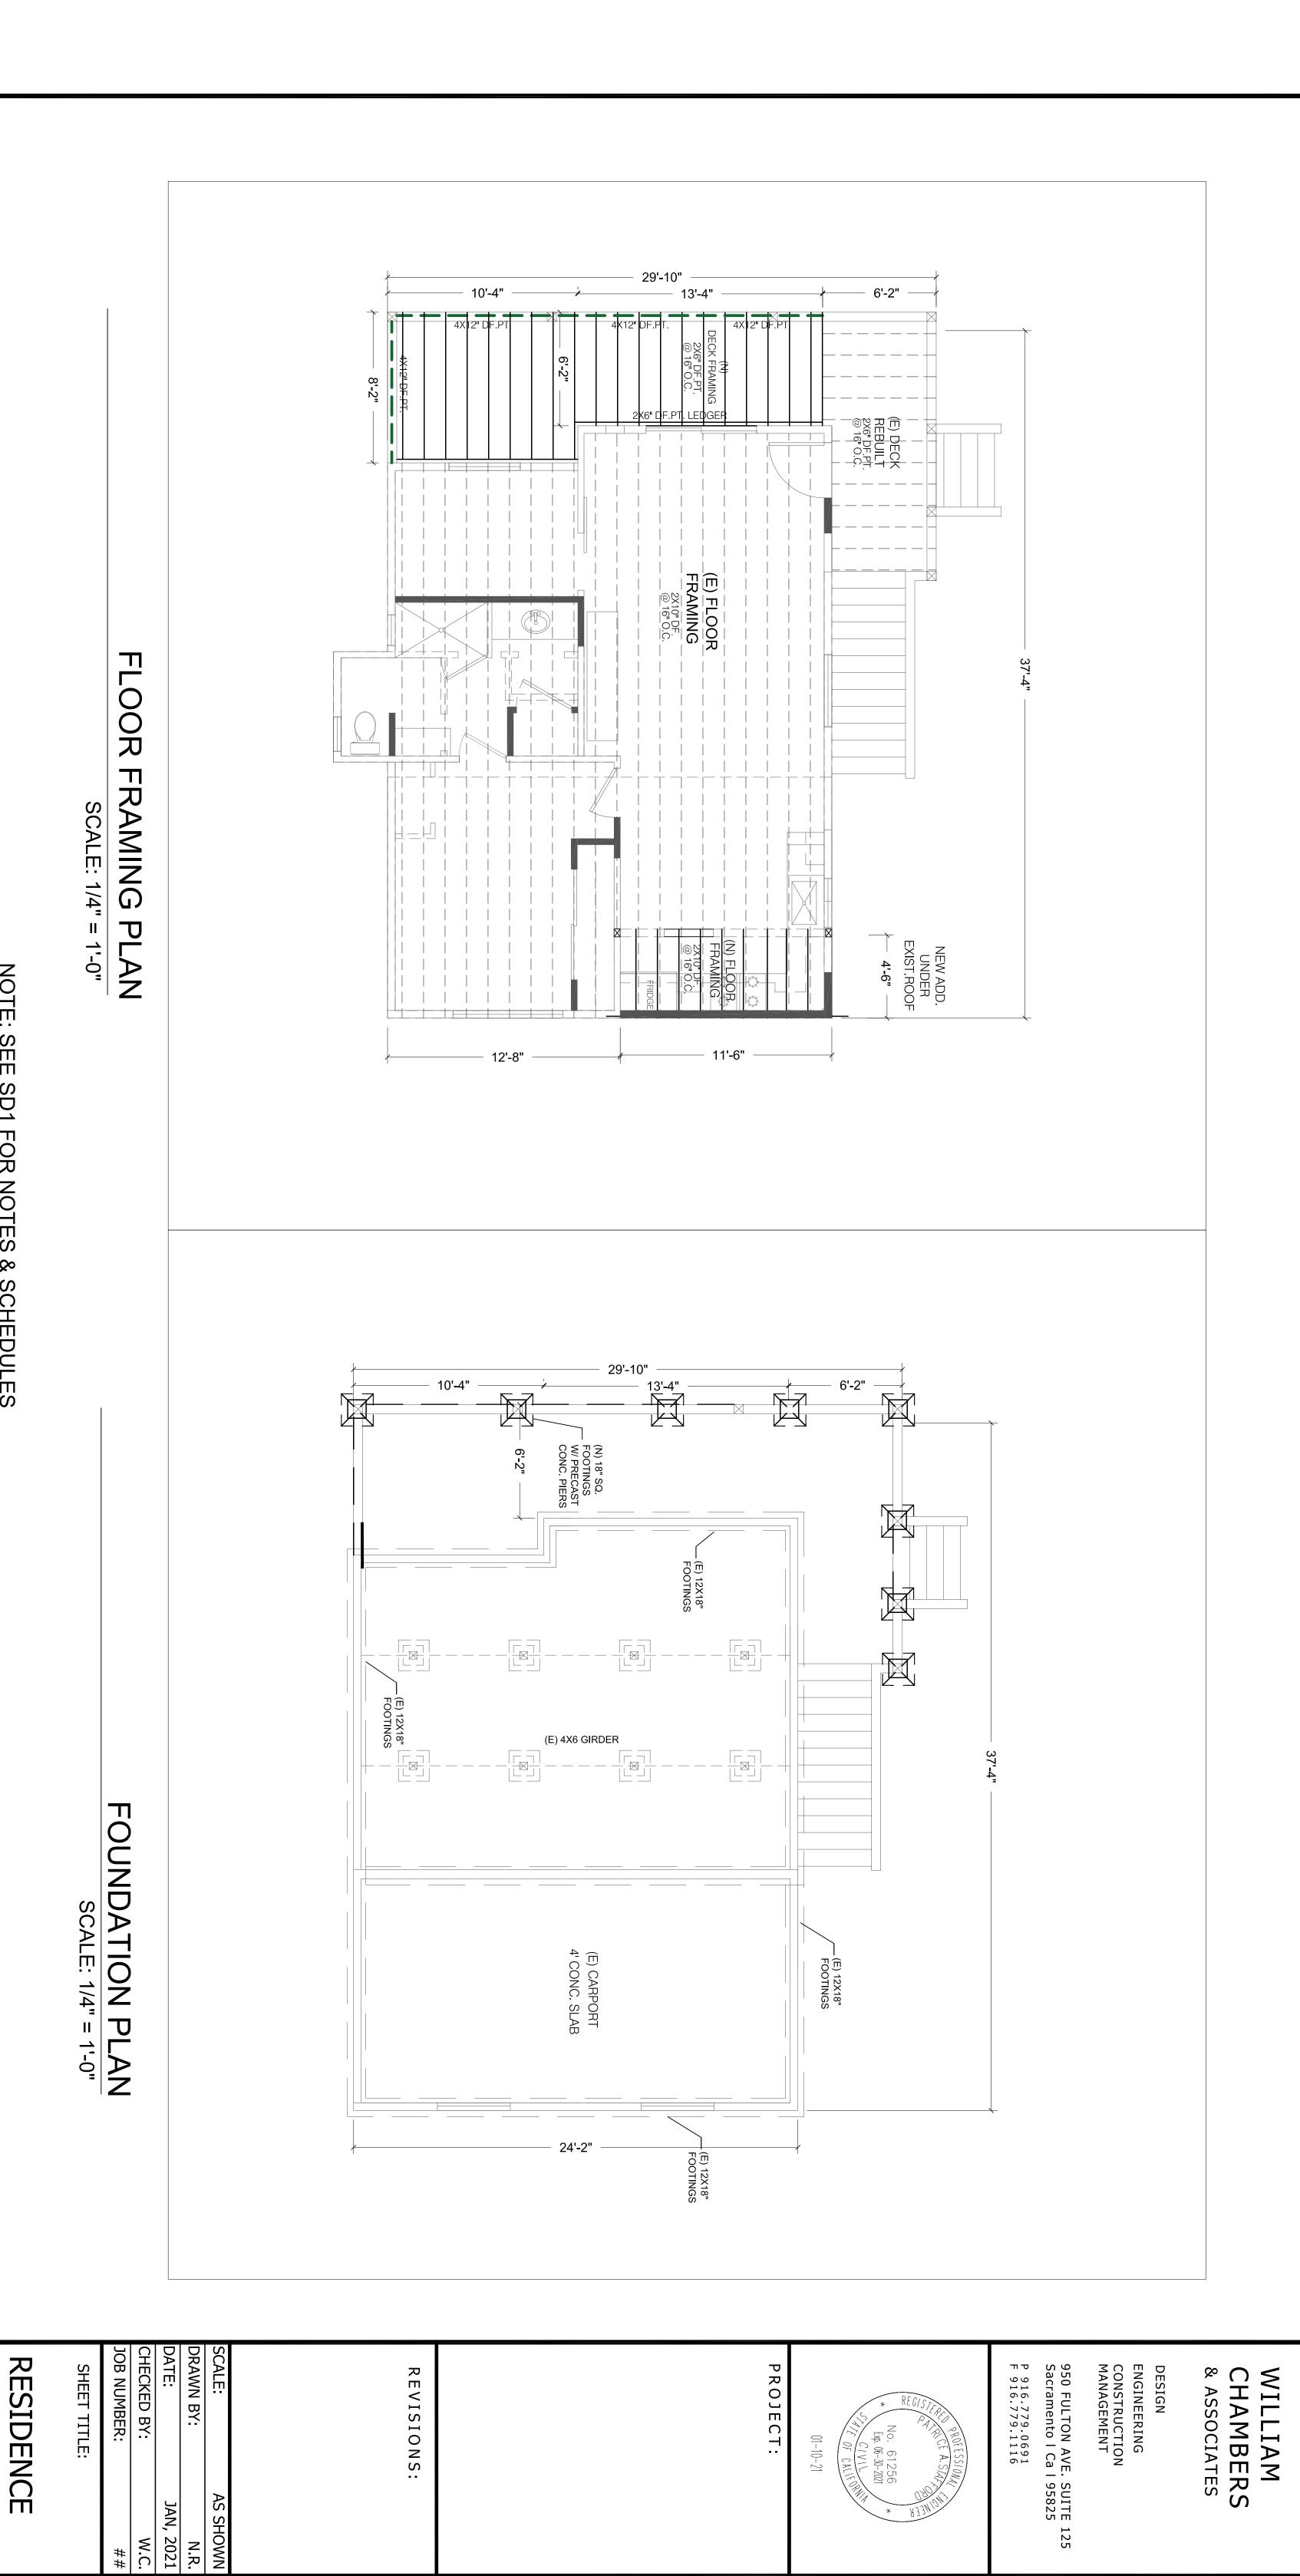

NOTE: SEE SD1 FOR NOTES & SCHEDULES

**FRAMING** 

SHEET:

**S1.0** 

FOUNDATION

##

AND FLOOR

#### LEGEND

- DUPLEX OUTLET 1/2 HOT OUTLET
- AFCI PROTECTED OUTLET
- 220 OUTLET 1/2 HOT AFCI PROTECTED OUTLET
- GFI WP
- 220 DISCONNECT WEATHERPROOF GFCI OUTLET-WEATHERPROOF JUNCTION BOX
- PENDANT LIGHT CEILING MOUNTED LIGHT
- WALL MOUNTED LIGHT WALL SCONCE
- ₽/M PHOTO CONTROLLED AND MOTION SENSORED WALL MOUNTED LIGHT WALL MOUNTED LIGHT BAR
- KEYLESS CEILING MOUNTED LIGHT RECESSED CAN LIGHT LED
- PHOTO CONTROLLED AND MOTION SENSORED RECESSED CAN
- EXHAUST FAN
- (h) COMBINATION EXHAUST FAN AND LED LIGHT FIXTURE HIGH EFFICACY LED CLG. MOUNTED LIGHT

HIGH EFFICACY LED CAN LIGHT 26W

- COMBINATION EXHAUST FAN AND LED HIGH EFFICACY LIGHT FIXTURE LED FIXTURE (UNDER CAB.) 22 WATTS LED FIXTURE (UNDER CAB.) 15 WATTS
- SWITCH LED FIXTURE (UNDER CAB.) 30 WATTS
- DIMMER SWITCH 3-WAY SWITCH
- DIMMER 3 -WAY SWITCH
- OCCUPANT SENSOR SWITCH. MANUAL ON.
- SMOKE DETECTOR TO SOUND ALARM AUDIBLE IN ALL SLEEPING AREAS AND SHALL BE HARDWIRED WITH BATTERY BACKUP.

  CARBON MONOXIDE ALARM
- THERMOSTAT

PUSHBUTTON

- OPTIONAL SECURITY
- TELEPHONE OUTLET TV OUTLET
- CAMERA

FG

FUEL GAS

- KEY FIREPLACE KEY (LOOSE) HOSE BIBB WITH NON-REMOVABLE BACKFLOW PREVENTION DEVICE
- RECESSED STUB-OUT FOR ICE-MAKER
- RETURN AIR GRILL
- ILLUMINATED ADDRESS
- 12" X 48", LED FIXTURE WITH LENS

24" X 48", 3 LED FIXTURE WITH LENS, (32 WATTS EA.) 96 WATTS

(E) 200 AMP ELEC. SERVICE  $\Rightarrow$ NOTE: KITCHEN OUTLETS E AF¢I & GFI (<u>a</u> 220V OUTLET WITH
WEATHER PROOF
BOX THAT CONNECTS
A 30 AMP
DISCONECTOR 2'-6" 02 RIDGE 0

## **ELECTRICAL PLAN**

SCALE: 1/4" = 1'-0"

### GENERAL ELECTRICAL NOTES 1. THE USE OF 110V SMOVE PROPERTY.

- INTHE USE OF 110V SMOKE DETECTOR(S) WITH BATTERY BACK UP

  (WHICH ARE AUDIBLE IN ALL SLEEPING AREAS) AT THE

  FOLLOWING NEWLY CONSTRUCTED LOCATIONS, SMOKE

  DETECTORS SHALL BE INTERCONNECTED PER CRC R314.3

  PROVIDE BOND METALLIC GROUND FOR GAS AND WATER PIPES

  PER CEC 250.104 (a&b)

  ALL 15A OR 20A 120 V BRANCH CIRCUITS SUPPLYING OUTLETS (RECEPTACLES

  LIGHTS, DETECTOR POWER, ETC) ARE REQUIRED TO BE AFCI PROTECTED

  AT KITCHENS, FAMILY ROOMS, DINING ROOMS, LIVING ROOMS

  BEDROOMS, RECREATION ROOMS, CLOSET, LAUNDRY ROOMS, HALLWAYS AND

  SIMILAR ROOMS PER CEC 210.12

  FIXTURES, LAMP HOLDERS, AND RECEPTACLE SHALL BE SECURELY

  SUPPORTED. A FIXTURE THAT WEIGHS MORE THAN SIX POUNDS

  OR EXCEEDS 16" IN ANY DIMENSION, SHALL NOT BE SUPPORTED

  BY SCREW OF THE SHELL OF A LAMP HOLDER PER CEC 410-20 (a)

  OUTLET BOXES SHALL NOT BE USED AS THE SOLE SUPPORT

  FOR CEILING FANS PER CEC 314-27 (d)

  RECEPTACLES SHALL BE SPACED NOT MORE THAN 12' APART

  AND MINIMUM OF 6' FROM ENDS OF WALLS OR OPENING.

  RECEPTACLES SHALL BE SPACED NOT MORE THAN LENGHT

  PER CEC 210-52 (a)

  CONDUCTOR WIRES WITH INSULATED NEUTRAL AND A FOUR PRONG

  OUTLET IS REQUIRED FOR DRYERS AND COOKING APPLIANCE PER

  CEC 250-140

  BATHROOM RECEPTACI FS SHALL BE SUPPLIANCE PER

- CEC 250-140

  CEC 250-140

  CEC 250-140

  AL HATROOM RECEPTACLES SHALL BE SUPPLIED BY ONE 20 AMP CIRCUIT SUCH CIRCUIT SHALL HAVE NO OTHER OUTLETS PER CEC 210-52 (d)

  ALL KITCHEN AND BATHROOM LIGHT FIXTURES TO HAVE A MINIMUM EFFICACY OF 40 LUMENS PER WAIT.

  STEEL ELECTRICAL BOXES ARE REQUIRED IN FIRE-RESISTIVE WALLS AND CEILINGS. SEPARATE ELECTRICAL BOXES BACK TO BACK IN FIRE RESISTIVE WALLS AND CEILINGS BY A MINIMUM OF 24\*

  POUTTY-PADS) AND DOX AREA SHALL NOT EXCEED 16 IN 2

  PER CRO R302.44.2#1

  10. OUTLET BOXES OR OUTLET BOX SYSTEMS USED AS THE SOLE SUPPORT FOR CEILING (PADDLE) FANS, SHALL BE LISTED. SHALL BE MARKED BY THEIR MFR. AS SUITABLE FOR THIS PURPOSE AND SHALL NOT SUPPORT FOR LAUNDRY EQUIPMENT, AND SHALL BE LISTED. SHALL BE MARKED BY THEIR MFR. AS SUITABLE FOR THIS PURPOSE AND SHALL NOT SUPPORT FOR LAUNDRY EQUIPMENT, AND SHALL BE INSTALLED IN ADDITION TO ANY PROVIDED FOR LAUNDRY EQUIPMENT, AND SHALL BE INSTALLED IN ADDITION TO ANY SHALL NOT SUPPORT CEILING-SUSPENDED (PADDLE) FANS THAT WEIGH MORE THAN 3294 (70b), PER CEC 310-52 (f)

  11. AUNDRY ROOMMAREAS PER CEC 210-52 (f)

  12. PROVIDED TWO SMALL APPLIANCE BRANCH CIRCUIT FOR THE PROVIDED FOR LAUNDRY EQUIPMENT, AND SHALL BE INSTALLED IN LAUNDRY ROOMMAREAS PER CEC 210-52 (f)

  12. PROVIDED TWO SMALL APPLIANCE BRANCH CIRCUIT FOR THE PROVIDED FOR PER CEC 210-52 (f)

  13. ALL 15 AND 20 AMP RECEPTACLE OUTLETS IN THIS DWELLING UNIT SHALL BE TAMPER RESISTANT RECEPTACLES.

  14. GROUPED COUNTERTOPMANL OUTLET INCLUDING THE RECEPTACLES INSTALLED IN THE FOLLOWING LOCATION IS REQUIRED WITHIN AN ARC MEASUREMENT OF 6' FROM OUTSIDE EDGE OF A BATHTUB OR SHOWER STALL.

  LAUNDRY AREAS. RECEPTACLES INSTALLED IN LAUNDRY AREAS OF A DWELLING UNIT SHALL BE EDGE OF THE GARAGE.

  15. THE BRANCH CIRCUIT SERVING THE GARAGE RECEPTACLES SHALL NOT SERVE OUTLETS

  16. THE BRANCH CIRCUIT SERVING THE GARAGE RECEPTACLES SHALL NOT SERVE OUTLETS

### FLOOR PLAN NOTES

- MAIN ELECTRICAL PANEL AND METER 400 AMP

  FUSED DISCONNECT WEATHERPROOF ENCLOSURE. VERIFY LOCATION.

  EXIST. TELEPHONE AND CABLE POC

  BATH FANS:
  PANASONIC WHISPER GREEN TO BE CONTROLLED BY A HUMIDISTAT
  AND ENERGY STAR RATED

  DECORATIVE LIGHT FIXTURE
- DICATED GFI DISH WASHER OULET
- PROVIDE DUPLEX OUTLET FOR HOOD

  PROVIDE DUPLEX OUTLET FOR RANGE

  DEDICATED RECEPTACLE FOR SPRINKLER TIMER

  DEDICATED MICROWAVE OUTLET

  DEDICATED REFRIGERATOR OUTLET

  DOOR BELL CHIME AT +84" LOCATE STEP DOWN TR

  IN GARAGE TCHED DUPLEX OUTLET FOR

## CARBON MONOXIDE NOTE

CARBON MONOXIDE ALARMS SHALL BE INSTALLED WITH BATTERY BACK-UP IN DWELLING UNITS WITH FUEL BURNING APPLIANCES OR WITH ATTACHED GARAGES, WHERE MORE THAN ONE CARBON MONOXIDE ALARM IS REQUIRED TO BE INSTALLED THE ALARM SHALL BE INTERCONNECTED IN A MANNER THAT ACTIVATION OF ONE ALARM SHALL ACTIVATE ALL OF THE ALARMS IN THE INDIVIDUAL UNIT PER CRC R315 AND SHALL BE "LISTED" AS COMPLYING WITH UL 2034 AND UL 2074 PER CRC R315.3

TITLE 24 LIGHTING NOTES

- 2016 CALIFORNIA ENERGY CODE MANDATORY MEASUREMENTS FOR RESIDENTIAL LIGHTING:
- ALL PERMANENTLY INSTALLED LUMINARIES IN DWELLING UNITS SHALL BE HIGH EFFICACY AND HAVE MANUAL ON/OFF CONTROLS AND VACANCY SENSORS OR DIMMERS EXCEPT FOR HALLWAYS & CLOSETS LESS THAN 70 sq.ft.
- UNDER CABINET LIGHTING MUST BE SWITCHED SEPARATE FROM ALL OTHER LIGHTING. EXHAUST FANS MUST BE SWITCHED SEPARATE FROM LIGHTING OR UTILIZE A DEVICE WHERE LIGHTING CAN BE TURNED OFF WHILE THE FAN IS RUNNING. EXCLUDES KITCHEN EXHAUST HOOD. PERMANENTLY INSTALLED LIGHTING IN CABINETS MUST BE HIGH EFFICACY.
- LIGHTING IN BATHROOMS, GARAGES, LAUNDRY ROOMS & UTILITY RILEAST ONE LUMINAIRE CONTROLLED BY VACANCY SENSORS.
- PERMANENTLY INSTALLED OUTDOOR LIGHTING ATTACHED TO RESIDENCE OR OTHER BUILDINGS MUST BE HIGH EFFICACY AND MUST BE CONTROLLED BY A MANUAL ON AND OFF SWITCH AND USE ONE OF THESE CONTROL TYPES:
- PHOTO-CONTROL AND MOTION SENSOR OR
   PHOTO-CONTROL AND AUTOMATIC TIME SWITCH CONTROL OR ASTRONOMICAL
  TIME CLOCK THAT AUTOMATICALLY TURNS OUTDOOR LIGHTING OFF DURING
  DAYLIGHT HOURS OR
   ENERGY MANAGEMENT CONTROL SYSTEM (EMCS) THAT PROVIDES THE
  FUNCTIONALLY OF AN ASTRONOMICAL TIME CLOCK.

### WHOLE HOUSE VENTILATION:

PROVIDE A SWITCH WHICH IS LABELED "FAN SHOULD BE ON WHENEVER THE HOME IS OCCUPIED"
THE SYSTEM MUST BE DESIGNED SO IT CAN OPERATE AUTOMATICALLY BASED ON A TIMER.
THE INTERMITTENT MECHANICAL VENTILATION SYSTEM MUST OPERATE FOR AT LEAST ONE HOUR
PER DAY AND MUST OPERATE AT LEAST 10% OF THE TIME.
THE VENTILATION AIRFLOW IS INCREASED TO RESPOND TO THE FEWER HOURS OF FAN OPERATION
AND THE TENDENCY OF POLLUTANT CONCENTRATIONS TO BUILD UP DURING OFF CYCLES.
THE FAN MUST BE LISTED AT 1 SONE OR LESS FOR NOISE.
RATING BASED ON WATER COLUMN OF .25 OR GREATER
G"MIN DICT SIZE

### KITCHEN HOOD EXHAUST:

Z LINE 36" 1200 CFM 6" MIN DUCT SIZE RATING BASED ON WATER COLUMN OF .25 OR GREATER

ELECTRICAL



#### CHAMBERS WILLIAM


& ASSOCIATES

CONSTRUCTION MANAGEMENT

ENGINEERING

DESIGN

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REMODEL RESIDENCE PROJECT:

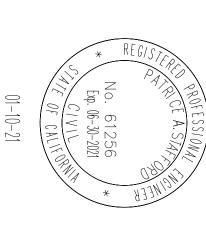Diamond Springs, 791 North Cir Dr,

REVISIONS: CA 95619

DATE: DRAWN BY: JOB NUMBER: CHECKED BY: SHEET TITLE: NMOHS SA JAN, 2021 ⊗ C N.R. ##

PLAN RESIDENCE

SHEET:

**4** EXIST.  $\widehat{\mathbb{E}}$ ဝ  $\widehat{\mathbb{H}}$ (E) CARPORT 2  $\sim$ NEW DECK (E) ROOF ယ NEW ADD. UNDER EXIST.ROOF  $\widehat{\mathbb{H}}$ LEFT ELEVATION  $\stackrel{\textstyle (E)}{}$ - (N) SIDING TO MATCH EXIST. (E) DECK SCALE: 1/4" = 1'-0" 4 ± 0'-0" ± 0'-0"

RIGHT ELEVATION

SCALE: DRAWN BY:

REVISIONS:

DATE:

N.R. JAN, 2021

JOB NUMBER:

SHEET TITLE:

**EXTERIOR** 

**ELEVATIONS** 

RESIDENCE

CHECKED BY:

W.C.

##

SCALE: 1/4" = 1'-0"

NOTE: SEE AD1&2 FOR EXTERIOR DETAILS

SHEET:

A3.0

DESIGN
ENGINEERING
CONSTRUCTION
MANAGEMENT PROJECT: P 916.779.0691 F 916.779.1116 950 FULTON AVE. SUITE 125 Sacramento | Ca | 95825 & ASSOCIATES **CHAMBERS** WILLIAM REMODEL RESIDENCE CA 95619 Diamond Springs, 791 North Cir Dr, 01-10-21

KEYNOTES


1 STANDING SEAM METAL ROOF

HARDI SIDING BOARD AND BATTEN

4 PREFORMED METAL GUTTER

TREX DECK

TRIM AROUND ALL WINDOWS & DOORS

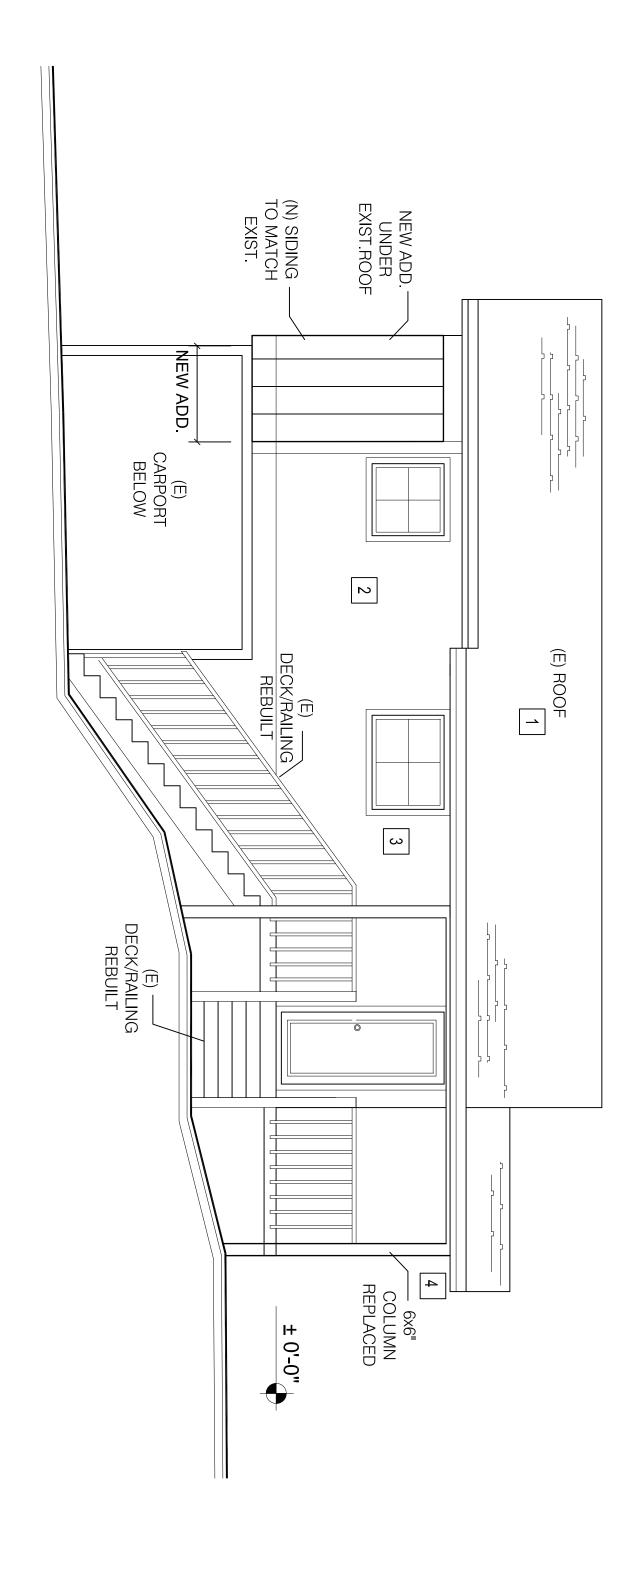

# FRONT ELEVATION

SCALE: 1/4" = 1'-0"

Diamond Springs, CA 95619

REVISIONS:


791 North Cir Dr,

REMODEL

RESIDENCE

PROJECT:

01-10-21

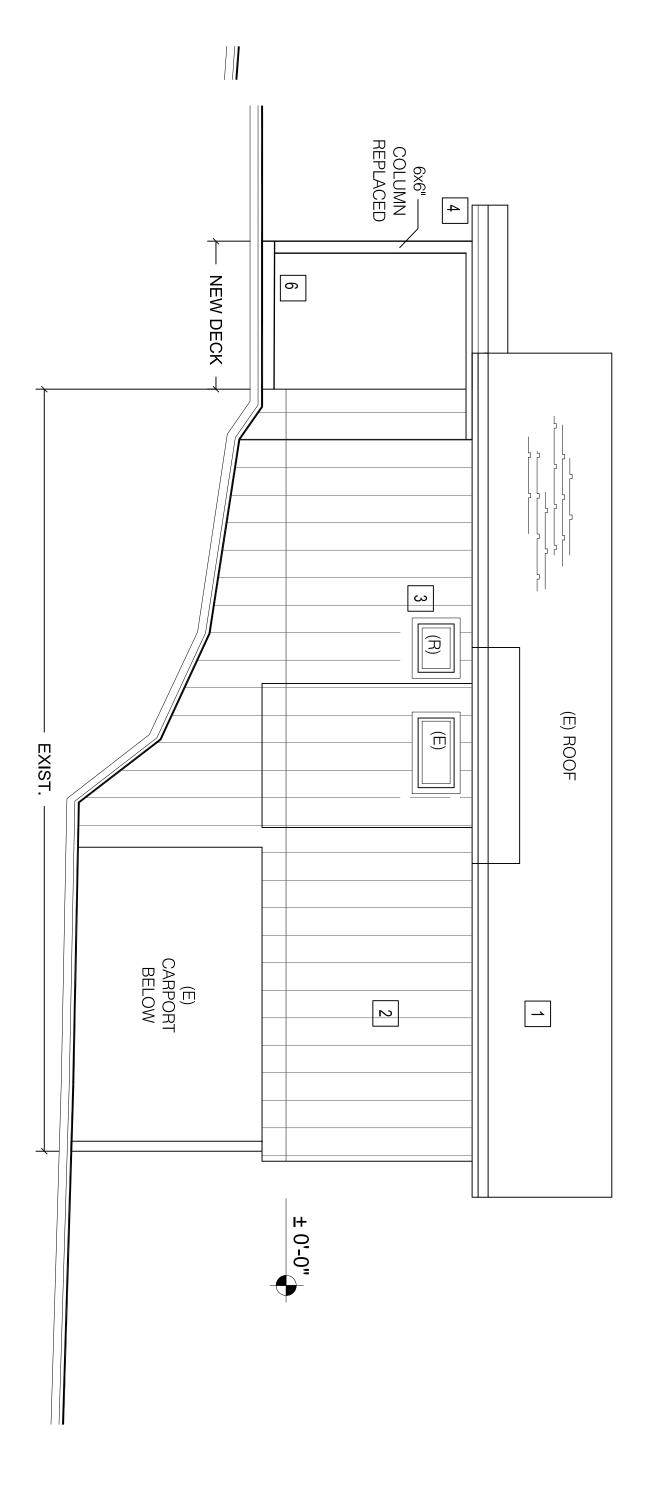

REAR ELEVATION

SCALE: 1/4" = 1'-0"

KEYNOTES

2 HARDI SIDING BOARD AND BATTEN 1 STANDING SEAM METAL ROOF

3 TRIM AROUND ALL WINDOWS & DOORS PREFORMED METAL GUTTER

FASCIA

TREX DECK

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DESIGN
ENGINEERING
CONSTRUCTION
MANAGEMENT

WILLIAM
CHAMBERS
& ASSOCIATES

**ELEVATIONS** RESIDENCE **EXTERIOR** 

CHECKED BY:
JOB NUMBER:

##

SHEET TITLE:

DRAWN BY: DATE:

N.R. JAN, 2021


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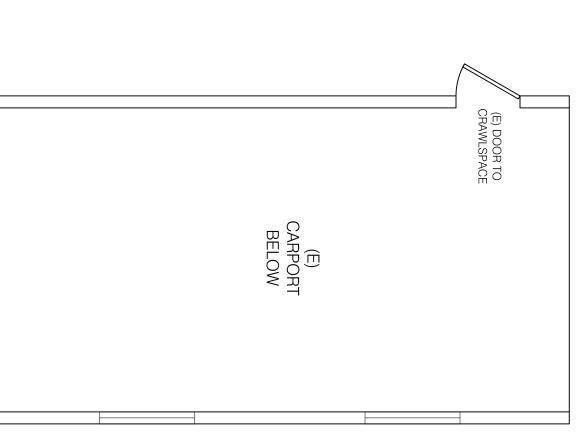
AS SHOWN

SHEET:

A2.0

NOTE: SEE AD1&2 FOR EXTERIOR DETAILS



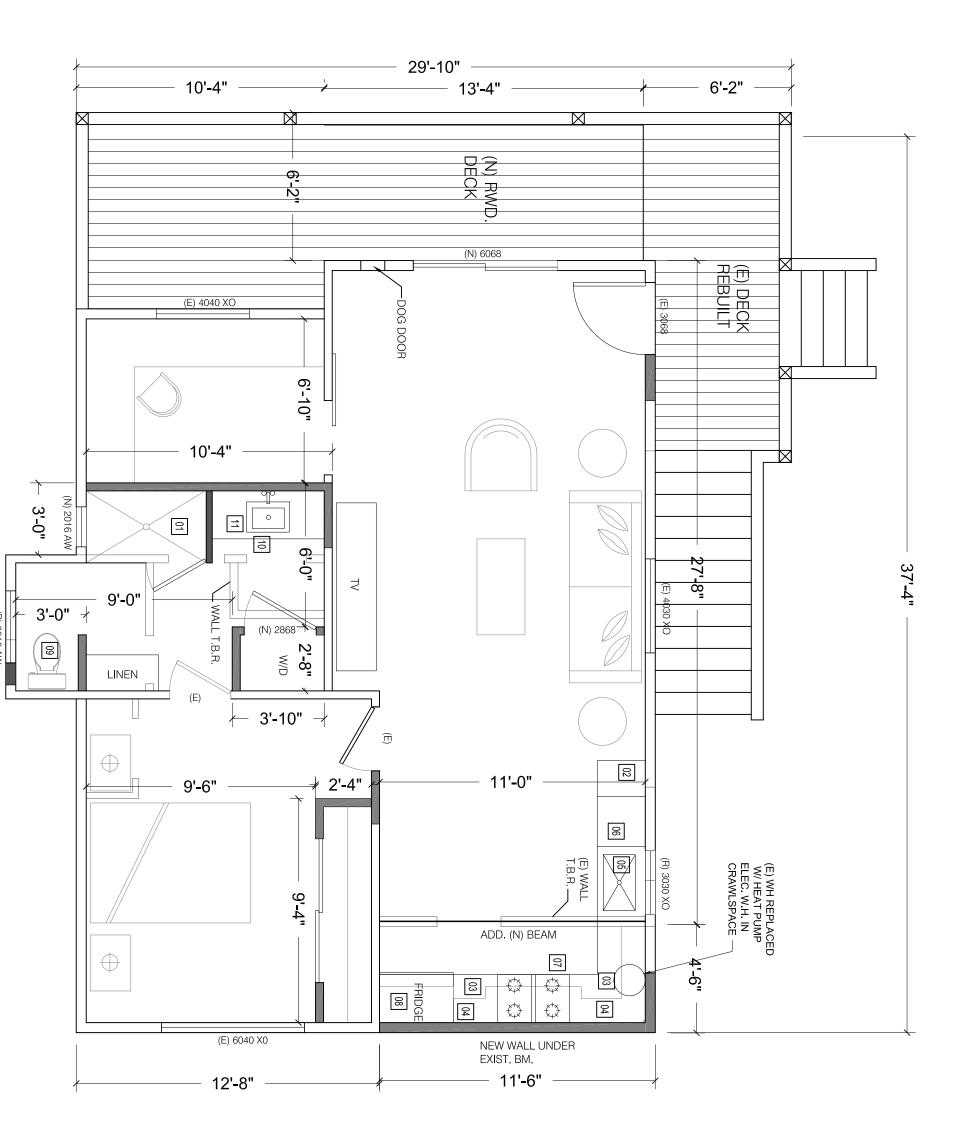

TILE SHOWER W/ MUD SET TILE WAINSCOT TO +72 PER CRC R 307.2 OVER LISTED HARDI BACKER BD. NO PAPER BACKED WALL BD. 18" PANTRY

11 10 08 07 06 05 04 03 02 01

SINK; a) SINGLE BASIN W/ DISPOSAL

DISH WASHER -PROVIDE AIR GAP

36" STOVE W/ HOOD @ +30" ABOVE

36" REFRIGERATOR (PROVIDE WATER S'

WATER CLOSET

LAVATORY

WATER PIPING TO "PEX" PIPING. CONTRACTOR TO SUBMIT AN "ALTERNATE MATERIALS AND METHODS OF CONSTRUCTION" FORM TO THE BUILDING DEPT. FOR APPROVAL. PROVIDE MANUFACTURER LISTING AND INSTALLATION GUIDE LINES OF MATERIALS.

SHOWERS and TUB/SHOWER COMBINATION SHALL BE PROVIDED with PRESSURE BALANCE or THERMOSTATIC MIXING CONTROL VALVES HANDLE POSITION STOPS SHALL BE ADJUSTED TO ALLOW A MAXIMUM WATER SETTING OF 120°F (49°C) PER CPC 408.6

SHOWER COMPARTMENT SHALL BE A MIN. FLOOR AREA 1,024 SQ. INCHES AND ENCOMPASS A 30" DIA. CIRCLE PER CPC 408.6

WATER CLOSET TO BE MAX 1.28 GALLONS PER FLUSH PER CPC 403.2

AND SHALL NOT BE INSTALLED CLOSER THA 15" FROM ITS CENTER TO ANY WALL OR OBSTRUCTION NOT CLOSER THA 30" CENTER TO CENTER OF ANY WALL OR OBSTRUCTION WITH A MIN. 24" CLEAR FLOOR SPACE IN FRONT THE WATER CLOSET PER CPC 402.5

ENGINEERING CONSTRUCTION MANAGEMENT

DESIGN

& ASSOCIATES

**CHAMBERS** 

WILLIAM

ALL PENETRATIONS INCLUDING CENTRAL VACUUM, PLUMBING, ELECTRICAL AND MECHANICAL RUNS THROUGH FIRE RATED ASSEMBLIES SHALL ME METALLIC EXTENDING A MINIMUM 12" FROM FACE OF WALL (INCLUDING TRAPS WHERE APPLICABLE) AND SHALL BE SEALED SO THAT HOT GASES CANNOT PASS THROUGH PER CRC R302.5
HOSE BIB WITH NON REMOVABLE BACKFLOW PREVENTION DEVICE PER CRC R602.0 AND R603.3

#### EGRESS NOTE

WALL LEGEND

NEW 2X6 DF#2 @ 16" O.C WOOD FRAMED WALL

NEW 2X4 DF#2 @ 16" O.C WOOD FRAMED WALL

EXIST. 2X6 DF#2 @ 16" O.C WOOD FRAMED WALL

EXIST. 2X4 DF#2 @ 16" O.C WOOD FRAMED WALL

EXIST. 2X4 WALL TO BE REMOVED WALL

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01-10-21

PROVIDE OPERABLE DOOR OR WINDOW, APPROVED FOR EMERGENCY ESCAPE, WHICH SHALL OPEN DIRECTLY INTO A PUBLIC STREET ALLEY, YARD OR EXIT COURT, FOR EVERY SLEEPING ROOM BELOW THE FOURTH STORY PER CRCR310.1 OPENING SHALL COMPLY A. MAXIMUM FINISHED SILL HEIGHT OF NOT MORE THAN 44" INCHES ABOVE THE FLOOR.

B. SHALL HAVE A MINIMUM NET CLEAR OPEN ABLE AREA OF 5.7 SQ. FEET
C. THE MINIMUM NET CLEAR OPEN ABLE HEIGHT DIMENSION SHALL BE 24" INCHES
D. THE MINIMUM NET CLEAR OPEN ABLE WIDTH DIMENSION SHALL BE 20" INCHES
E. ALL WINDOW CASEMENT (C).

PROJECT:

#### REMODEL RESIDENCE

CA 95619 Diamond Springs, 791 North Cir Dr,

REVISIONS:

BRACED WALL PANELS W/
3/8" PLY. W/ 8d NAILING @ 6" C.C.
5/8" GWB TYP. @ INT.SIDE OF WALL
ALTERNATE BRACED WALL PANELS W/
3/8" PLY. W/ 8d NAILING @ 6" C.C.
AND HOLDOWN PER SCHEDULE
5/8" GWB TYP. @ INT.SIDE OF WALL

SHEAR WALL PANELS W/ 3/8" PLY. W/ 8d NAILING @ 6" C.C.

S.W LEGEND

NOTE:
BRACED WALL FRAMING PER 2016 CRC CS-WSP
SEE SHEET SD1

W.C	CHECKED BY:
JAN, 2021	DATE:
N.R.	DRAWN BY:
AS SHOWN	SCALE:

FLOOR PLAN

SCALE: 1/4" =

1'-0"

1ST FLOOR RESIDENCE

WINDOW NOTATIONS:
AW AWNING
C CASEMENT
E EYEBROW
F FIXED
XO SLIDING
T TEMPERED

WINDOW NOTES

JOB NUMBER:

##

SHEET TITLE:

PLAN

SHEET: